


FRONT

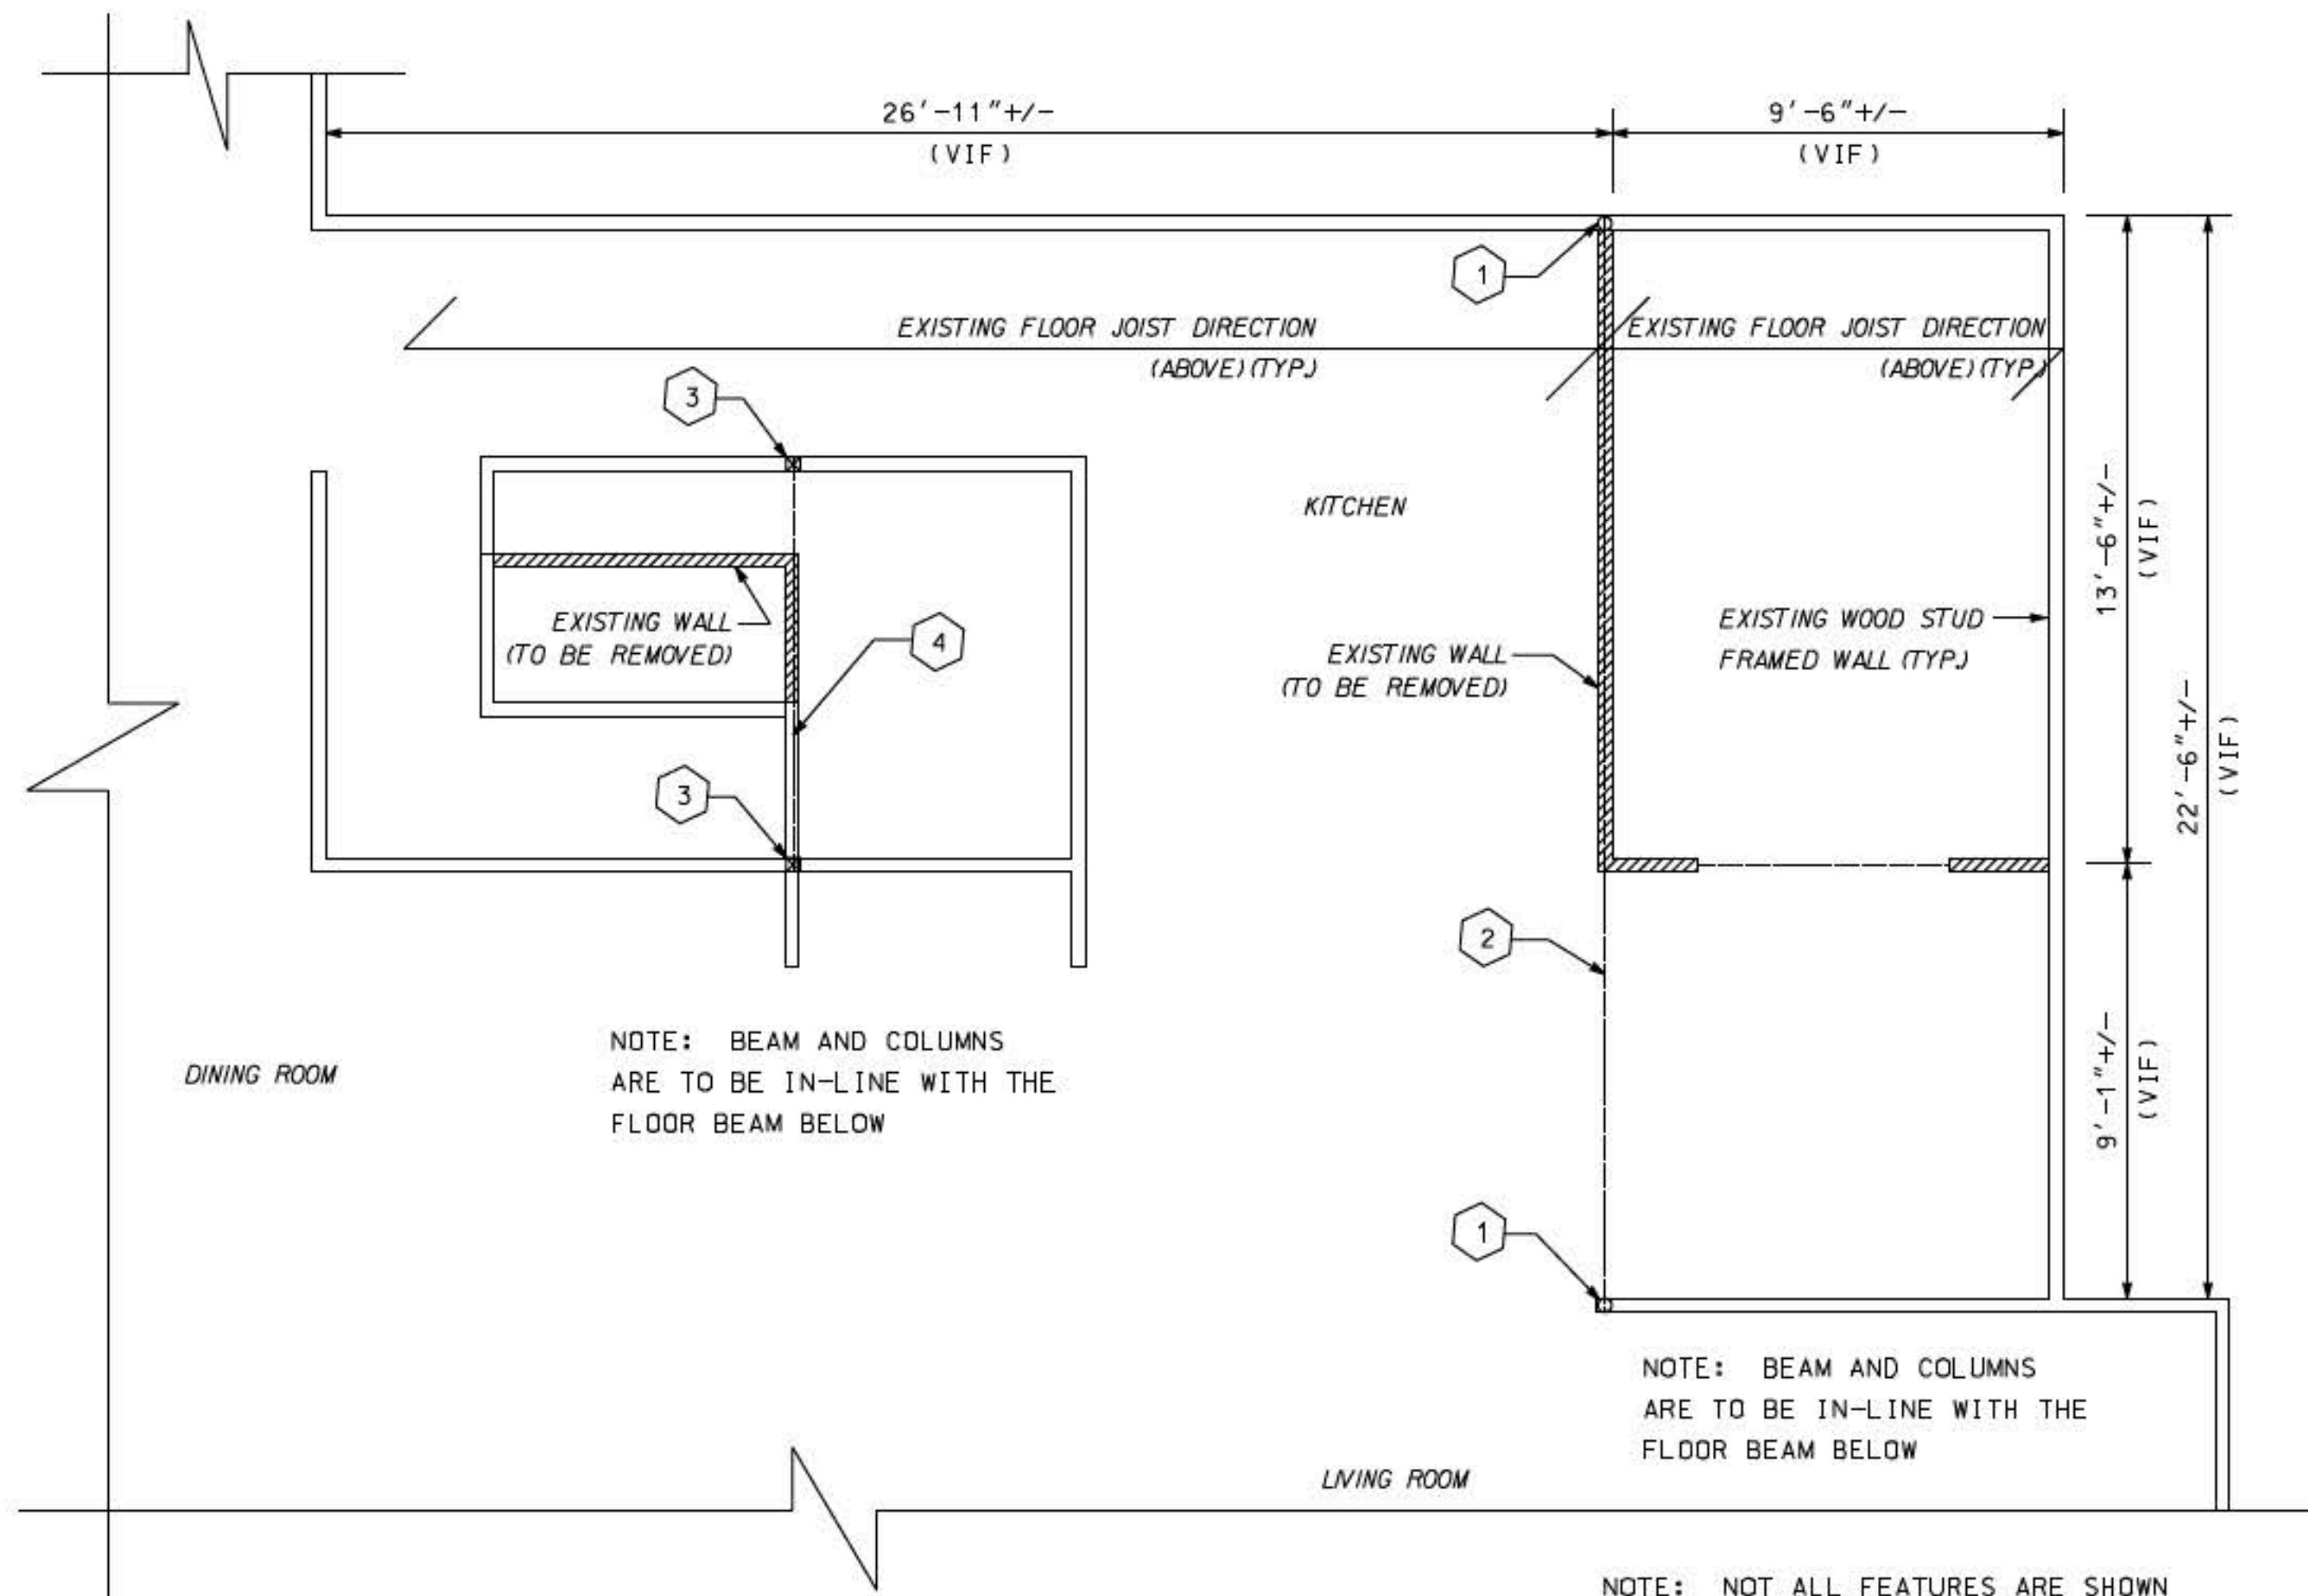

- 1 NEW COLUMN
3.5" DIA. HD STEEL PIPE (SCH80)
EXTEND TO FOUNDATION OR BEAM
- 2 NEW STEEL BEAM (DROP)
W16X36
- 3 NEW COLUMN
3 1/2" X 3 1/2"
1.9E LVL
- 4 NEW WOOD BEAM
3 1/2" X 11 7/8"
2.0E PSL

(VIF) = VERIFY IN FIELD. BY CONTRACTOR, PROJECT MANAGER AND OWNER PRIOR TO THE START OF ANY WORK.

EXISTING 1ST FLOOR FRAMING PLAN (PARTIAL)

SCALE: 3/16" = 1'-0"



PROPOSED
FRAMING ALTERATIONS
FOR

P.O. BOX 2651
CINNAMINSON, NJ 08077
PHONE: (856) 829-8636
WWW.PENNVALLEYENGINEERING.COM
CERTIFICATE OF AUTHORIZATION NO. 24GA28116200

CREGORY S. BAKER, P.E. DATE
PROFESSIONAL ENGINEER, NEW JERSEY LICENSE NO. 24GE04509700

REVISIONS:

SCALE: AS NOTED
DRAWN BY: DMB
DATE: MAY 8, 2023
PROJECT No. MDNTG
DRAWING No.

S-1

GENERAL NOTES:

GENERAL CONSTRUCTION


- DO NOT SCALE DRAWING TO OBTAIN DIMENSIONS.
- ALL WORK SHALL BE EXECUTED IN AN ORDERLY AND CAREFUL MANNER, WITH DUE CONSIDERATION FOR OWNER, EMPLOYEES, AND THE PUBLIC SAFETY.
- GC SHALL PROVIDE DUST AND ACCESS BARRICADES AS REQUIRED, SO AS TO PROTECT PROPERTY, ADJACENT STRUCTURES, UTILITIES, STREETS, PEDESTRIANS, AND THE GENERAL PUBLIC.
- GC SHALL CONFIRM ALL FIELD CONDITIONS AND DIMENSIONS, AND SHALL BE SOLELY RESPONSIBLE FOR THEM.
- IF WORK EXPOSES ANY CRACKS, SEPARATIONS OR OPENINGS, THEN THE GC WILL NOTIFY ENGINEER, WILL CLEAN AND FILL WITH NON-SHRINK GROUT, AND WILL FOLLOW ENGINEER'S OTHER INSTRUCTIONS.
- GC SHALL FURNISH ALL NECESSARY AND REQUIRED TEMPORARY OR PERMANENT SHORING, BRACING, SUPPORTS, ETC.
- GC SHALL NOTIFY ENGINEER OF ANY AND ALL DIFFERING SITE CONDITIONS.
- THE ENGINEER SHALL NOT BE IN CHARGE OF OR RESPONSIBLE FOR THE CONSTRUCTION METHODS, TECHNIQUES, SEQUENCES, PROCEDURES, OR FOR SAFETY PRECAUTIONS IN CONNECTION WITH THE CONSTRUCTION WORK OR THE ACTS OR OMMISIONS OF THE GC, SUBCONTRACTOR, OWNER OR ANY OTHER PERSON PERFORMING ANY WORK, OR FAILURE OF ANYONE TO CARRY OUT THE WORK IN ACCORDANCE WITH THE CODES.
- THE ENGINEER IS NOT RESPONSIBLE FOR SITE CONDITIONS. PRIOR TO BIDDING OR CONSTRUCTION, THE GC SHALL BE RESPONSIBLE TO VERIFY ALL SITE CONDITIONS AND DIMENSIONS ON THE DRAWINGS AND NOT ON THE DRAWINGS AND NOTIFY ENGINEER IN WRITING OF ANY DISCREPANCIES.
- ALL WORK SHALL CONFORM TO THE NJ-IRC 2021 AND REHAB SUBCODE.
- SIZE AND/OR LOCATION OF EXISTING STRUCTURES AND UTILITIES SHOWN ON THE STRUCTURAL DOCUMENTS ARE FOR THE CONTRACTORS CONVENIENCE ONLY. THE CONTRACTOR IS SOLEY RESPONSIBLE TO VERIFY BY FIELD MEASUREMENTS/INVESTIGATION THE SIZE AND/OR LOCATION OF ALL EXISTING STRUCTURES AND UTILITIES.

EXISTING CONDITIONS

- THE EXISTING CONSTRUCTION SHOWN ON THESE DRAWINGS IS PROVIDED FOR REFERENCE ONLY. EXISTING CONSTRUCTION, DIMENSIONS, LOCATIONS, ELEVATIONS, ETC. SHALL BE VERIFIED IN THE FIELD (VIF) PRIOR TO REMOVAL OR MODIFICATION OF ANY EXISTING STRUCTURAL MEMBER AND/OR SHOP DRAWING PREPARATION, FABRICATION, AND CONSTRUCTION OF ANY NEW WORK.
- SHOULD EXISTING CONDITIONS DIFFER FROM THAT SHOWN ON THE CONTRACT DOCUMENTS, CONTRACTOR SHALL NOTIFY THE ENGINEER PRIOR TO CONTINUATION OF WORK.
- EXISTING STRUCTURAL MEMBERS SHALL NOT BE CUT OR MODIFIED UNLESS SPECIFICALLY SHOWN HEREIN OR UNLESS PRIOR WRITTEN APPROVAL BY THE ENGINEER IS OBTAINED.
- CONTRACTOR SHALL TAKE NECESSARY PRECAUTIONS TO PROTECT THE EXISTING STRUCTURE AND ADJACENT STRUCTURES FROM DAMAGE DURING SHORING, LIFTING, EXCAVATING, DEMOLITION, AND CONSTRUCTION OF NEW WORK.
- EXISTING STRUCTURAL DOCUMENTS ARE NOT AVAILABLE. VERIFY IN FIELD (VIF) EXISTING CONDITIONS, STRUCTURAL MEMBER SIZES, AND LOCATIONS, PRIOR TO NEW WORK.

MEANS AND METHODS

- THE CONTRACTOR IS RESPONSIBLE FOR PROVIDING MEANS AND METHODS FOR THE CONSTRUCTION OF THE PROJECT.
- THE CONTRACTOR SHALL ENGAGE A PROFESSIONAL ENGINEER FOR MEANS AND METHODS OF CONSTRUCTION, INCLUDING BUT LIMITED TO SCAFFOLDING, SHORING, UNDERPINNING, TEMPORARY BRACING, HOISTING, AND STORING OF MATERIAL OR EQUIPMENT ON THE EXISTING STRUCTURE.
- THE CONTRACTORS ENGINEER SHALL REFER TO SITE STANDARDS AND GUIDELINES FOR ADDITIONAL REQUIREMENTS.
- THE CONTRACTOR SHALL INSPECT, ACCESS, AND VERIFY THE EXISTING CONDITIONS AND EXTENT OF WORK PRIOR TO COMMENCING DEMOLITION OR CONSTRUCTION OF NEW WORK.
- THE CONTRACTOR SHALL PROVIDE NECESSARY EQUIPMENT AND OTHER PERTINENT MATERIAL, INCLUDING BUT NOT LIMITED TO LADDERS, LIFTS AND OTHER CONSTRUCTION EQUIPMENT FOR THE COMPLETION OF THE WORK INDICATED ON THE CONTRACT DOCUMENTS.
- THE CONTRACTOR SHALL PROVIDE SAFETY AND FALL PROTECTION IN ACCORDANCE WITH OSHA REGULATIONS AND SITE SAFETY GUIDELINES.

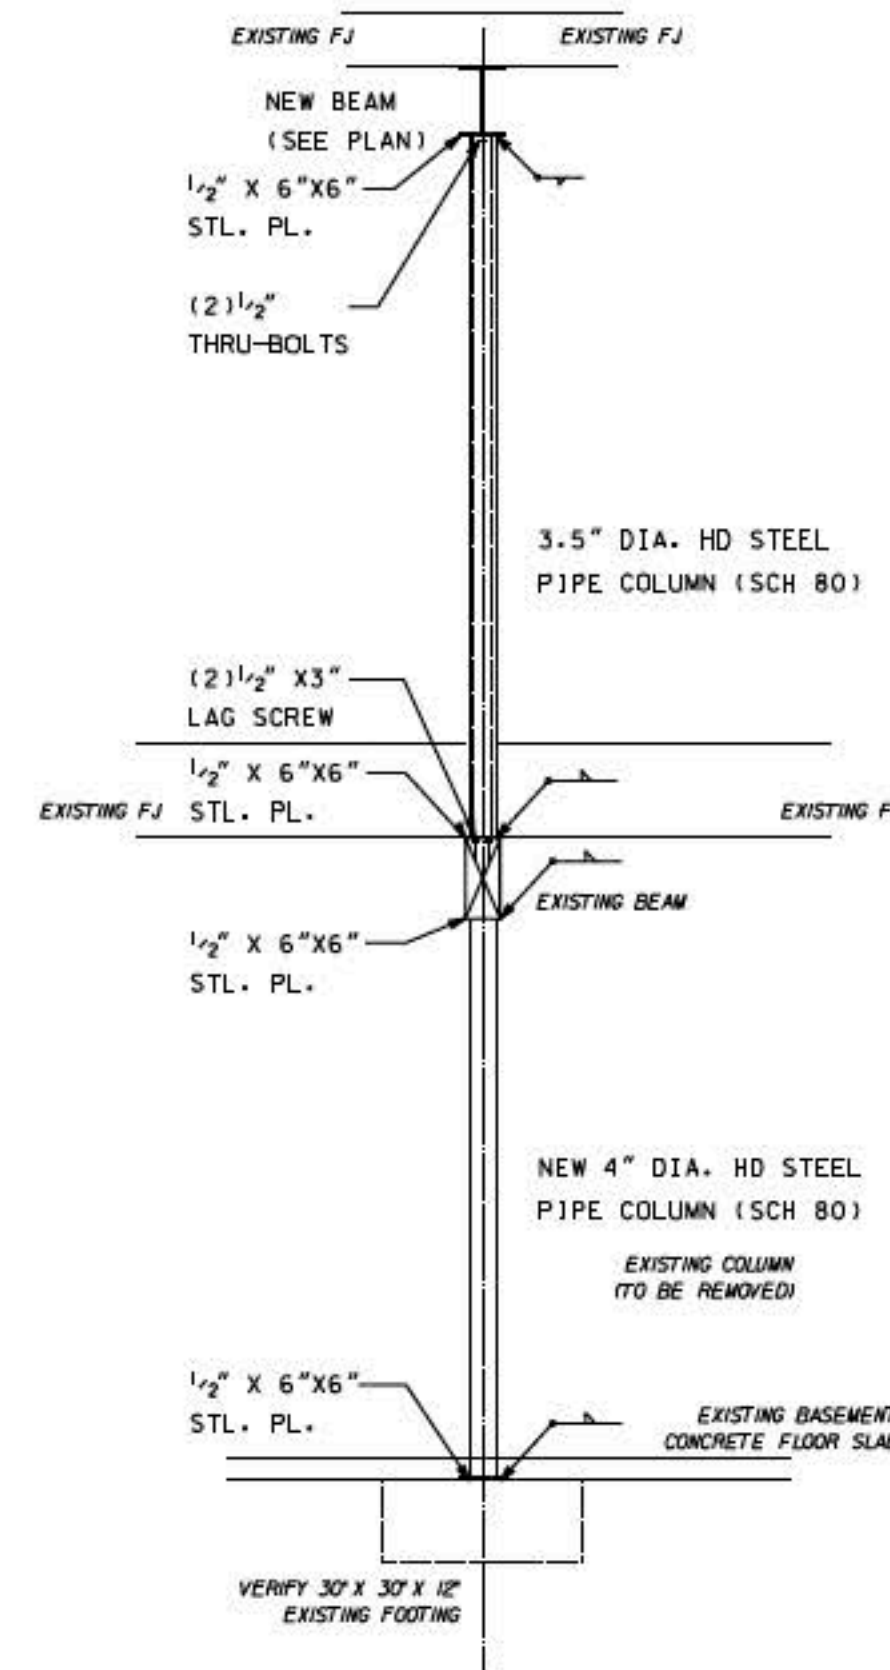

TYPICAL COLUMN/FOOTING SECTION

SCALE: NTS



**PROPOSED
FRAMING ALTERATIONS**

FOR

PENN VALLEY ENGINEERING, LLC
 P.O. BOX 2651
 CINNAMINSON, NJ 08077
 PHONE: (856) 829-8636
 WWW.PENNVALLEYENGINEERING.COM
 CERTIFICATE OF AUTHORIZATION NO. 24GA2816200
 GREGORY S. BAKER, P.E.
 PROFESSIONAL ENGINEER, NEW JERSEY
 LICENSE NO. 24GE04508700

REVISIONS:

SCALE: AS NOTED
 DRAWN BY: DMB
 DATE: MAY 8, 2023
 PROJECT No. MONTG
 DRAWING No.

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